


HOMESTEAD ROAD

SAFETY IMPROVEMENTS PROJECT 09-34

HOMESTEAD ROAD MEDIANS AND PATH, PROJECT 11-11

CITY OF LOS ALTOS, CALIFORNIA

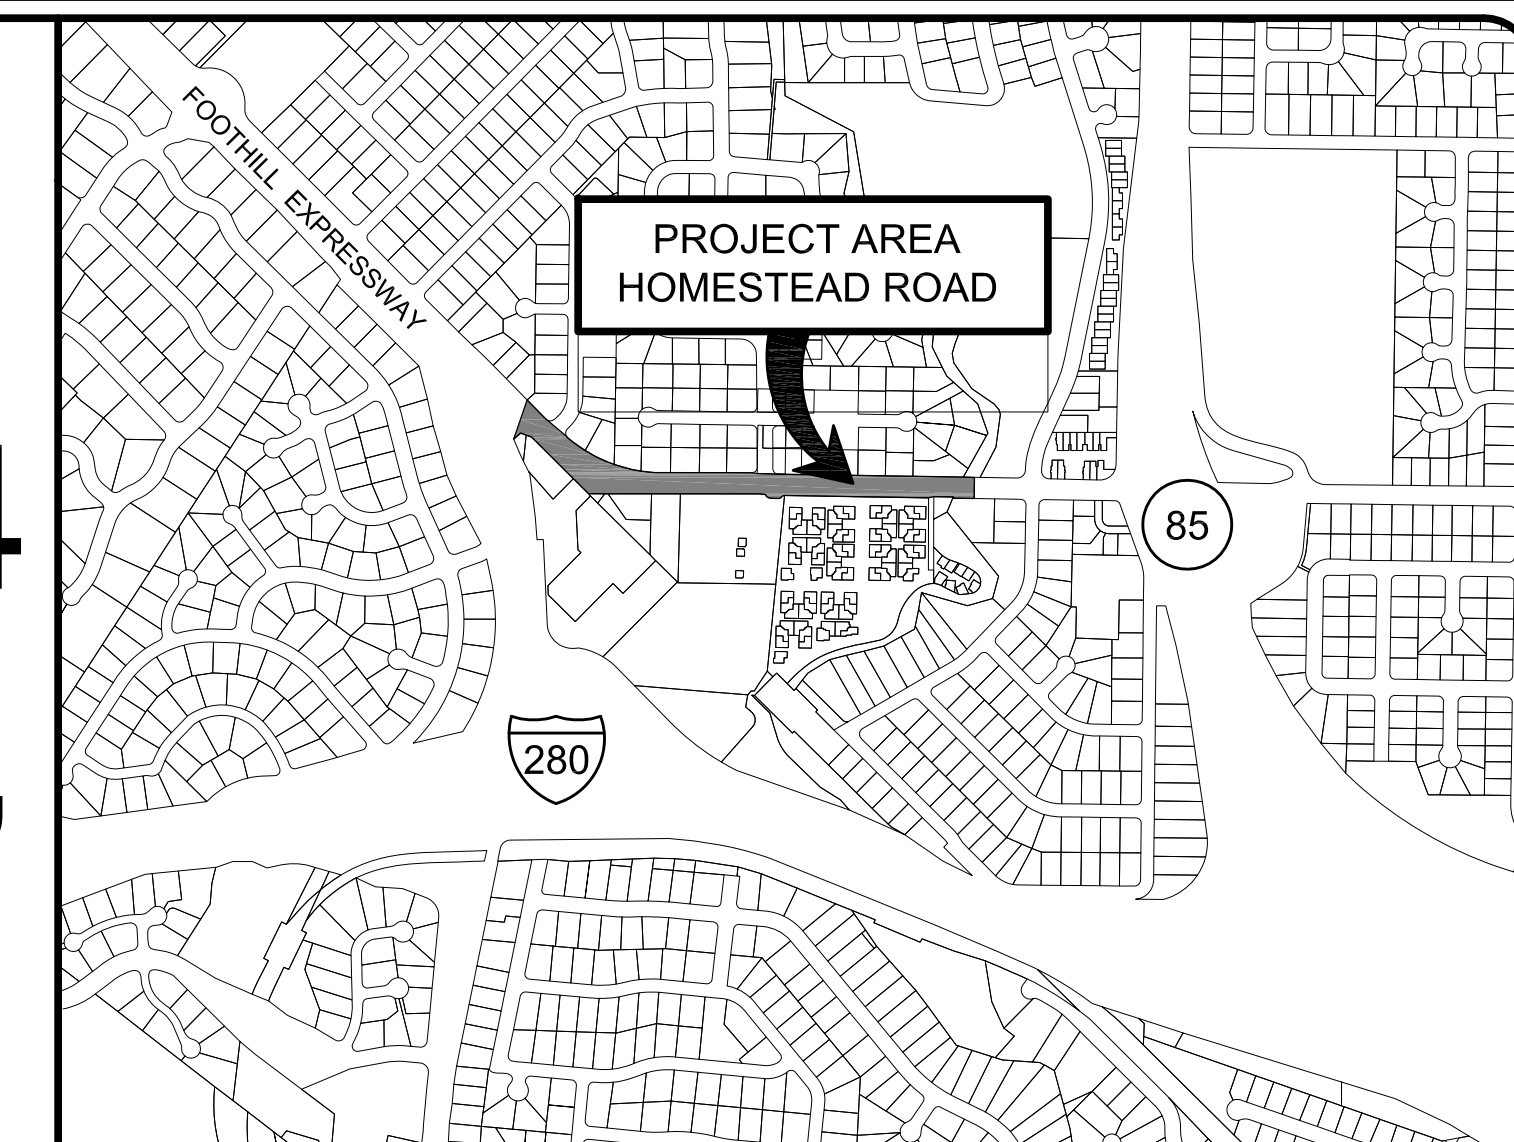

VICINITY MAP

NO SCALE



LOCATION MAP

ABBREVIATIONS

BC	BEGINNING OF CURVE
DWY	DRIVEWAY
EC	END OF CURVE
EP	EDGE OF PAVEMENT
EX	EXISTING
FL	FLOWLINE
GND	GROUND
HDPE	HIGH DENSITY POLYETHYLENE PIPE
INV	INVERT ELEVATION
LF	LINEAR FEET
PAV	PAVEMENT
PCC	PORTLAND CEMENT CONCRETE
PED	PEDESTRIAN
PP	POWER POLE
PRC	POINT OF REVERSE CURVATURE
RCP	REINFORCED CONCRETE PIPE
RP	RADIUS POINT
RW	RIGHT OF WAY
SD	STORM DRAIN
SS	SANITARY SEWER
SWK	SIDEWALK
TB	TOP OF BERM
TVC	TOP OF VERTICAL CURB
TC	TOP OF CURB
W	WATER

LEGEND

DESCRIPTION	EXISTING	PROPOSED
WATER LINE	— W — W —	
WATER VALVE	⊗	
FIRE HYDRANT	⊙	
FENCE	— □ — □ —	
STORM DRAIN	— SD —	— SD —
GAS LINE	— G —	
ELECTRIC LINE OVERHEAD	— P —	
ELECTRIC LINE UNDERGROUND	— E —	
MANHOLE	○	■
STORM DRAIN INLET	⊕	■
CURB	—	—
CURB & GUTTER	—	—
CURVE LABEL	⊕	⊕
SURVEY CONTROL POINT	OR ▲	OR ▲
STREET LIGHT	⊕	⊕
HANDICAP RAMP	⊕	⊕
POWER POLE	⊕	⊕
DIRECTION OF SURFACE FLOW	—	—
CITY LIMITS	—	—
PACIFIC BELL MANHOLE	⊕	⊕




EXISTING UTILITY NOTE:

EXISTING UNDERGROUND UTILITIES AND IMPROVEMENTS ARE SHOWN IN THEIR APPROXIMATE LOCATIONS BASED UPON RECORD INFORMATION AVAILABLE TO THE ENGINEER AT THE TIME OF PREPARATION OF THESE PLANS. LOCATIONS MAY NOT HAVE BEEN VERIFIED IN THE FIELD AND NO GUARANTEE IS MADE AS TO THE ACCURACY OR COMPLETENESS OF THE INFORMATION SHOWN. THE CONTRACTOR SHALL NOTIFY UTILITY COMPANIES AT LEAST 2 WORKING DAYS IN ADVANCE OF CONSTRUCTION TO FIELD LOCATE UTILITIES. CALL UNDERGROUND SERVICE ALERT (U.S.A.) AT 1-800-227-2600. IT SHALL BE THE RESPONSIBILITY OF THE CONTRACTOR TO DETERMINE THE EXISTENCE AND LOCATION OF UTILITIES SHOWN ON THESE PLANS, INDICATED IN THE FIELD BY LOCATING SERVICES, OR EVIDENCED BY FACILITIES VISIBLE AT OR ADJACENT TO THE JOBSITE. ANY ADDITIONAL COST INCURRED AS A RESULT OF THE CONTRACTOR'S FAILURE TO VERIFY LOCATIONS OF EXISTING UTILITIES PRIOR TO BEGINNING CONSTRUCTION SHALL BE BORNE BY THE CONTRACTOR AND IS DEEMED INCLUDED AND MERGED IN THE CONTRACT UNIT PRICE.

SHEET INDEX

SHEET NO.	TITLE
1	TITLE SHEET
2	EXISTING TOPOGRAPHY & SURVEY CONTROL
3	EXISTING TOPOGRAPHY & SURVEY CONTROL
4	DEMOLITION PLAN
5	DEMOLITION PLAN
6	PROJECT LAYOUT
7	PROJECT LAYOUT
8	PROJECT LAYOUT
9	GRADING PLAN
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11	SIGNING AND STRIPING PLAN
12	SIGNING AND STRIPING PLAN
13	DETAILS SHEET
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PLANS BY HEXAGON TRANSPORTATION CONSULTANTS, INC.	
15	E-1 TRAFFIC SIGNAL INSTALLATION
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17	E-3 IN-ROADWAY WARNING LIGHTS
PLANS BY BELLINGER FOSTER STEINMETZ	
18	L-1 IRRIGATION PLAN - WESTERN END
19	L-2 IRRIGATION PLAN - EASTERN END
20	L-3 PLANTING PLAN - WESTERN END
21	L-4 PLANTING PLAN - EASTERN END
22-24	L-5 TO L-7 IRRIGATION DETAILS

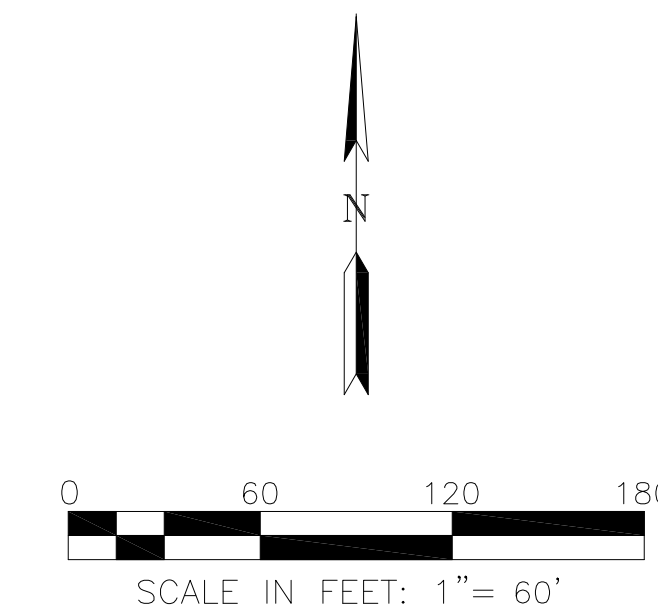

NOT FOR CONSTRUCTION

DRAWN LW	DESIGNED JS	HORIZONTAL SCALE 1"=60'
CHECKED LS	DATE CHECKED	VERTICAL SCALE
APPROVED		CONTRACT NO.
ENGINEER	DATE	

PREPARED BY:



REVISIONS

NO.	DATE	BY	DESCRIPTION	APPR.	DATE



CITY OF LOS ALTOS

HOMESTEAD ROAD SAFETY IMPROVEMENTS

TITLE SHEET

PREPARED FOR: CITY OF LOS ALTOS

DRAWING NO.

1

SHT 1 OF 24